




## **TOP VIEW**

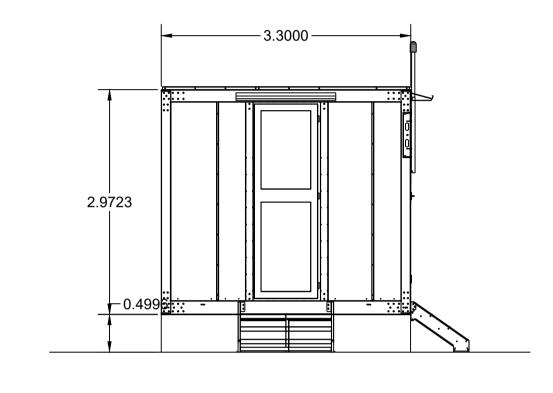

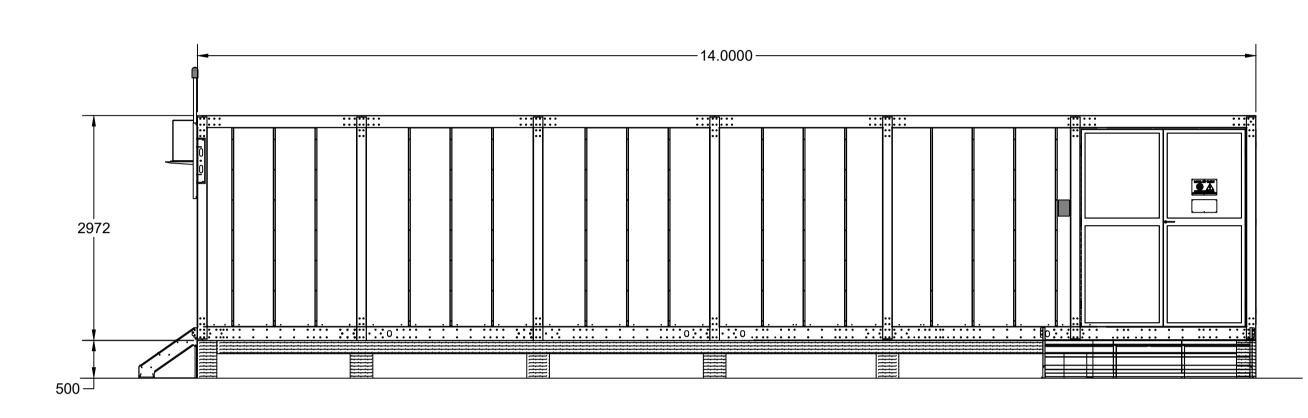


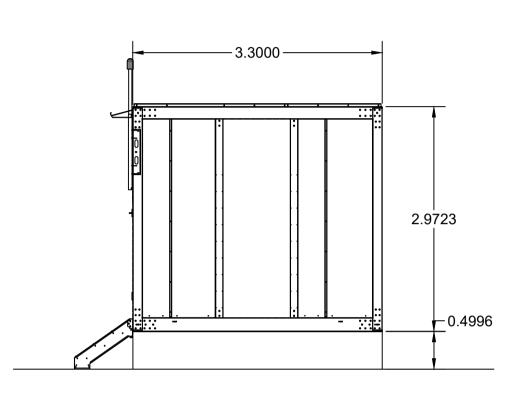

SIDE ELEVATION 'C'


FRONT ELEVATION 'A'

FRONT ELEVATION 'B'

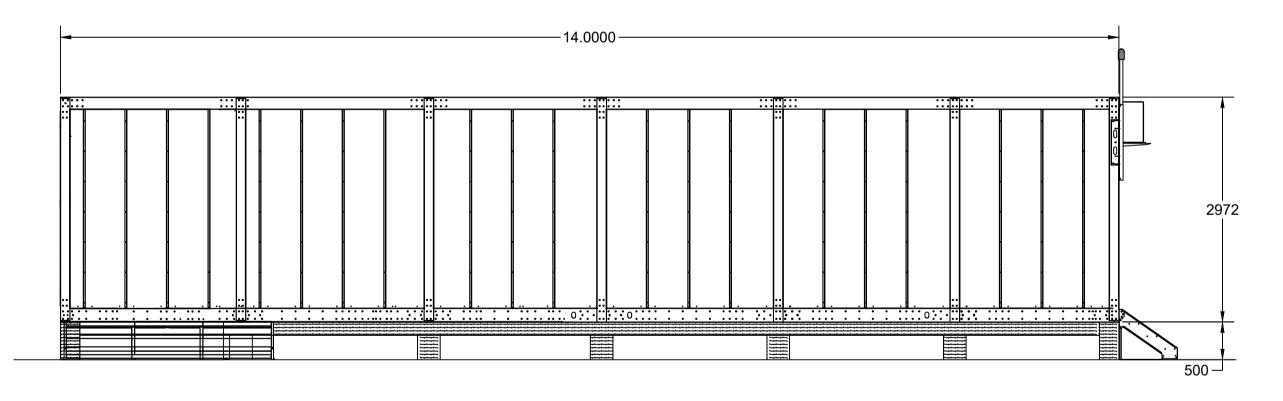

## REAR ELEVATION 'D'

'D'

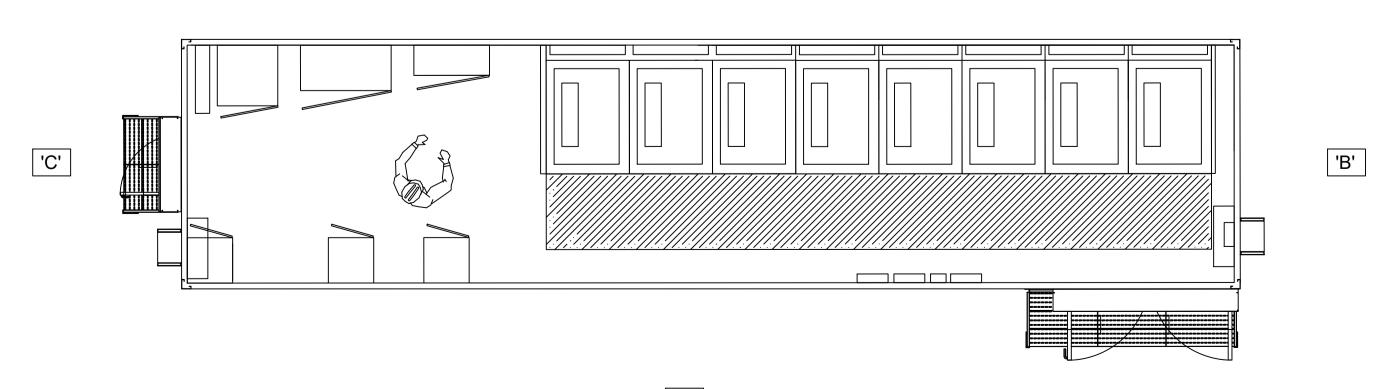

CUSTOMER SWITCHGEAR BUILDING

'A'
PLAN VIEW

0 1000 2500 5000 milimetres

Project: Lower Coalmoor BESS		
Drawing name: Plan and Elevations of Customer Switchgear Building		
ID: 88-1	<sup>ID:</sup> 88-10-16-P-PL-EQ-05	
R.01	Rear elevations added	07.09.2023
R.00	First Issue	11.08.2023
Revision	Description	Date
Discipline:	lectrical Phase: FOR PLANNING Format: Scale: 1:50	Sheet № 01 / 01

1. THIS DRAWING TO BE READ IN CONJUNCTION WITH ALL RELEVANT ENGINEERS AND SPECIALISTS DRAWINGS &

2. ANY DISCREPANCIES BETWEEN THIS DRAWING AND ANY OTHER TO BE REPORTED TO THE ENGINEER IMMEDIATELY.

4. ALL DIMENSIONS IN MILLIMETERS UNLESS STATED OTHERWISE. NO DIMENSIONS ARE TO BE SCALED OFF THE

5. ALL DIMENSIONS TO BE ±3mm UNLESS SPECIFIED

6. A RECESSIVE COLOUR SUCH AS GREY IS PROPOSED, BUT CAN BE AGREED WITH OFFICERS.

DRAWING. USE FIGURED DIMENSIONS ONLY.

3. ALL WORKS TO COMPLY WITH THE MOST CURRENT BRITISH

SPECIFICATIONS.

STANDARDS.

OTHERWISE.

Client: RE Project Development Limited



engineering info@renergy-bg.com www.renergy-bg.com

This drawing may not be reproduced or be made available to third person or competing companies without Renergy permission. The reproduction, distribution and utilization of this document as well as the communication of its contents without explicit authorization is prohibited. Offenders will be held liable and can findes up to 50% of the project cost: variations in design can occur to site conditions.

28 E Samokov str. 1113 Sofia, Bulgaria